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Suite 300
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T: 401.421.4140
F: 401.751.8613
www.gza.com

Via E-Mail and U.S. Mail

February 7, 2020 File No. 03.0033554.61

Ms. Crystal Charbonneau Rhode Island Department of Environmental Management (RIDEM) Office of Water Resources 235 Promenade Street Providence, Rhode Island 02908

Re: Notice of Termination (NOT) – WQC No. 16-115 and RIPDES RIR101439

Dike Access Road 121 Terminal Road Providence. Rhode Island

Dear Ms. Charbonneau:

On behalf of The Narragansett Electric Company d/b/a National Grid (National Grid), GZA GeoEnvironmental, Inc. (GZA) is pleased to present to the Rhode Island Department of Environmental Management (RIDEM) Office of Water Resources (OWR) the attached Notice of Termination (NOT) for the Dike Access Road Project (WQC No. 16-115 and RIPDES RIR101439) located at 121 Terminal Road in Providence, Rhode Island (herein referred to as the "Site"). This Notice of Termination (NOT) is being submitted in accordance with the requirements of the Water Quality Certification (WQC) and the Rhode Island Pollutant Discharge Elimination System (RIPDES) Construction General Permit (CGP) prepared by GZA dated June 29, 2016 and approved by RIDEM in a letter dated August 29, 2016. This NOT is subject to the limitations presented in Attachment A. Final site stabilization was achieved on June 7, 2019. Final construction documentation was completed on January 9, 2020.

GZA performed full time field oversight and quality assurance/quality control (QA/QC) for permit compliance during construction of the stormwater management system and associated Site improvements. Except as noted herein and in the attached, the stormwater management system, which consists of a water quality treatment system, was installed in accordance with the stormwater management plan and associated design drawings approved by RIDEM on August 29, 2016.

Construction as-built plans are presented as Attachment B. The construction as-built plans were prepared by Tauper Land Survey Inc. The final surface cover and stormwater system are depicted on the attached GZA Plan Set.

The signed Notice of Termination Form is provided in Attachment C. We note the drainage to the stormwater system was minimally altered from the original design by adding asphalt curbs to promote drainage to the treatment system.

Note that in accordance with WQC No. 16-115 and RIPDES RIR101439, National Grid is following the Operations and Maintenance Plan dated August 11, 2016 prepared as part of permitting for the Dike Access Road Project.



DEVIATIONS FROM THE RIDEM-APPROVED WQC

The following modifications were made to the RIDEM-approved stormwater management plan and are shown on the construction as-built plans provided in Attachment B:

1. The access road was equipped with two asphalt berms to direct runoff to the deep sump catch basin.

Should you have any questions or comments regarding the information presented herein, please do not hesitate to contact either of the undersigned or William Howard (National Grid) at (401) 784-7490.

Very truly yours,

GZA GEOENVIRONMENTAL, INC.

Sara Haupt, P.E. (RI)

Assistant Project Manager

Igor Runge, Ph.D. \(\sigma\)
Consultant Reviewer

Margaret Kilpatrick, P.E. (RI)

Associate Principal

Attachments:

Attachment A - Limitations

Attachment B – Stamped As-Built Plans and GZA Site Plans

Attachment C - Notice of Termination Form

CC: William Howard, National Grid

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ATTACHMENT A

LIMITATIONS

GEOHYDROLOGICAL LIMITATIONS


- This Letter has been prepared on behalf of and for the exclusive use of National Grid, solely
 for use in documenting the conditions observed at the property located at 642 Allens
 Avenue/121 Terminal Road in Providence, Rhode Island ("Site"). This letter and the findings
 contained herein shall not, in whole or in part, be disseminated or conveyed to any other
 party, nor used by any other party in whole or in part, without the prior written consent of
 GZA or National Grid.
- 2. GZA's work was performed in accordance with generally accepted practices of other consultants undertaking similar studies at the same time and in the same geographical area, and GZA observed that degree of care and skill generally exercised by other consultants under similar circumstances and conditions. GZA's findings and conclusions must be considered not as scientific certainties, but rather as our professional opinion concerning the significance of the limited data gathered during the course of the study. No other warranty, express or implied is made. Specifically, GZA does not and cannot represent that the Site contains no hazardous material, oil, or other latent condition beyond that observed by GZA during the performance of our Site investigations.
- The observations described in this report were made under the conditions stated therein.The conclusions presented in the report were based upon services performed and observations made by GZA.

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ATTACHMENT B

STAMPED AS-BUILT PLANS AND GZA SITE PLANS




NATIONAL GRID DIKE ACCESS ROAD PERMIT CLOSEOUT 642 ALLENS AVENUE PROVIDENCE, RHODE ISLAND FEBRUARY 2020

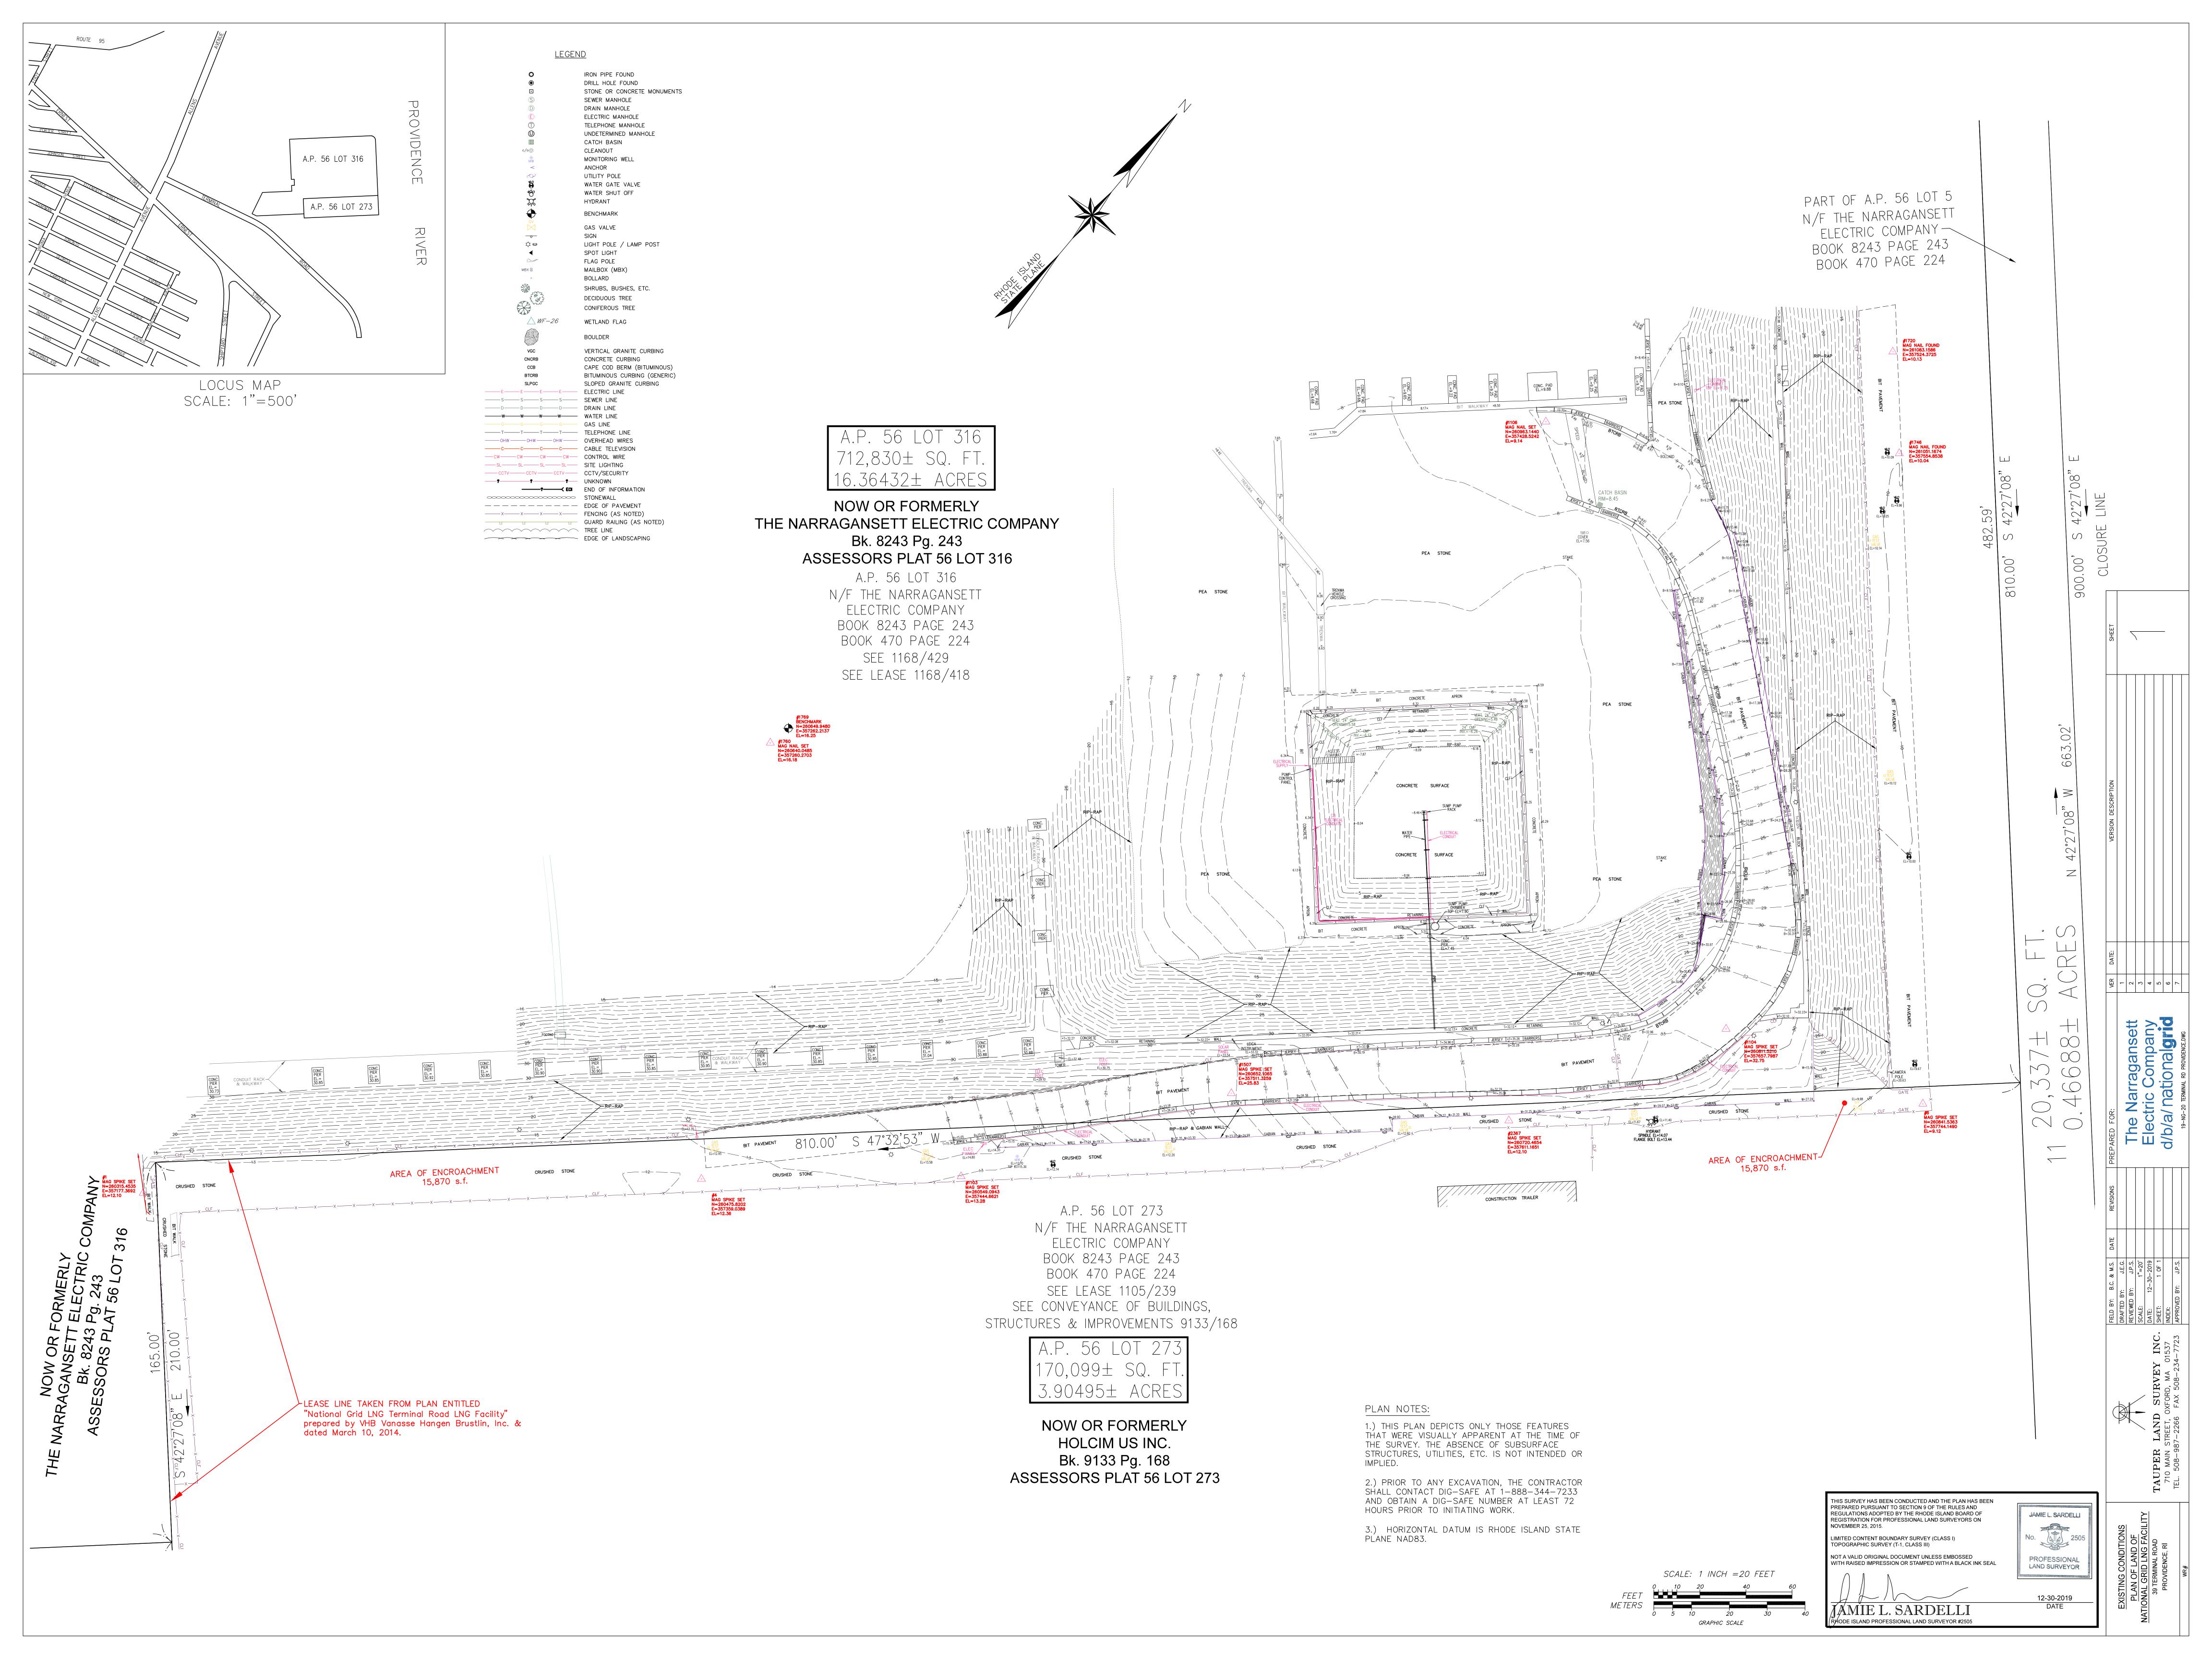PREPARED FOR:

nationalgrid

PREPARED BY:

GZA GEOENVIRONMENTAL, INC. 188 VALLEY STREET, SUITE 300 PROVIDENCE, RHODE ISLAND 02909

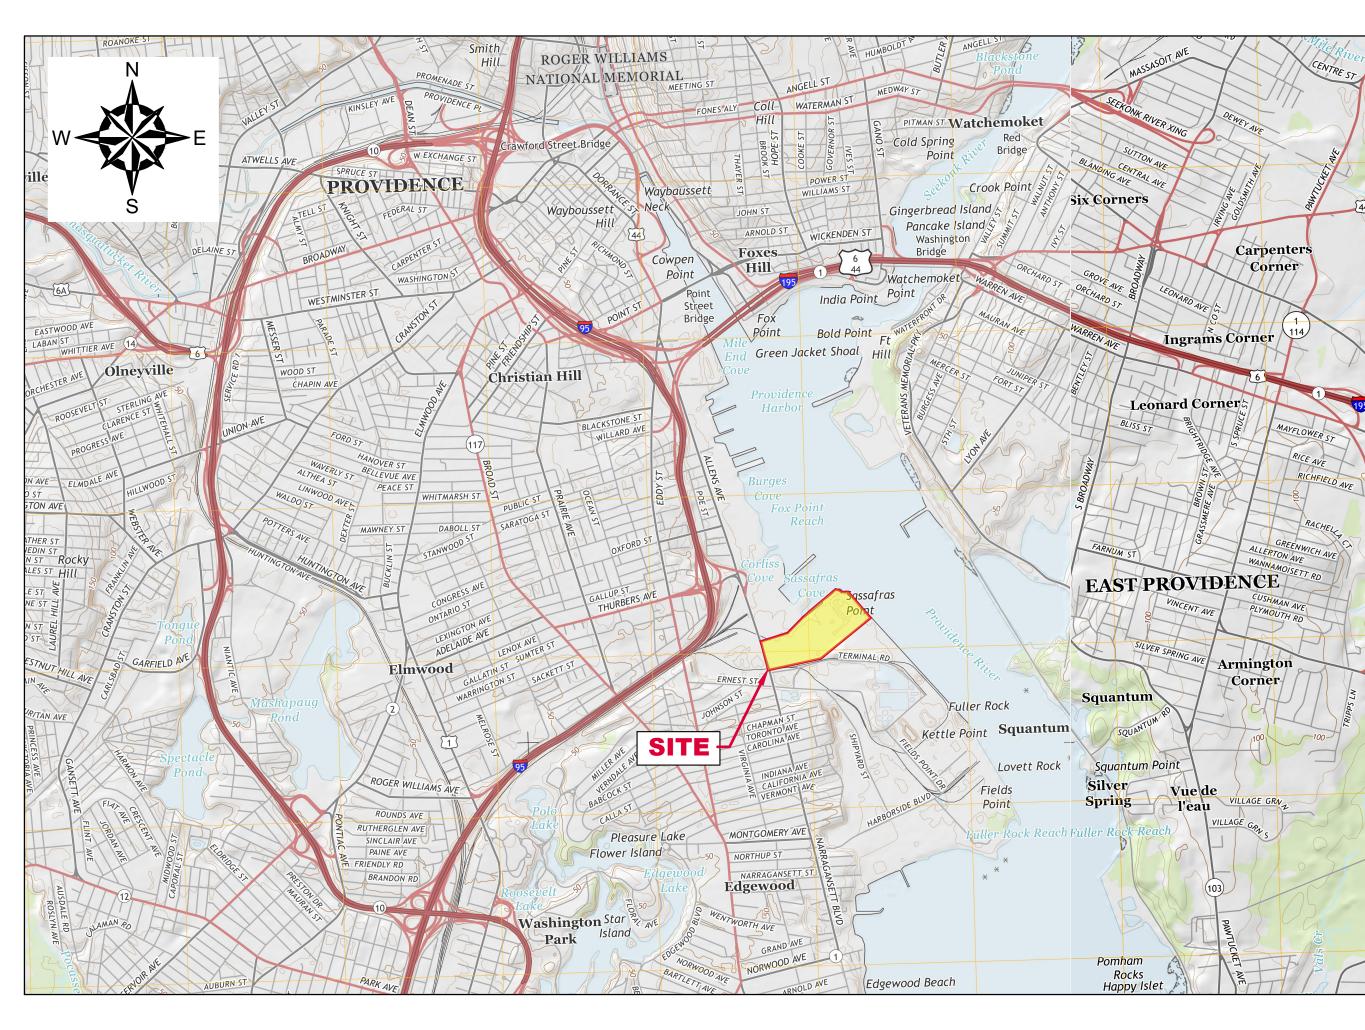

	INDEX OF DRAWINGS					
SHEET#	TITLE					
1	COVER SHEET, LOCUS AND INDEX TO DRAWINGS					
2	OVERALL AERIAL					
3	PRE-CONSTRUCTION SITE PLAN					
4	EXPLORATION LOCATION PLAN					
5	REMEDIAL CAP FINAL GRADING PLAN					
6	INSTALLED UTILITIES AND STORMWATER MANAGEMENT PLAN					
7	REMEDIAL CAP DETAILS					
3 4 5	PRE-CONSTRUCTION SITE PLAN EXPLORATION LOCATION PLAN REMEDIAL CAP FINAL GRADING PLAN INSTALLED UTILITIES AND STORMWATER MANAGEMENT PLAN					

LOCUS MAP

SOURCE: USGSSTORE.GOV


1000' 2000' 4000' 600


SCALE: 1 INCH = 2000 FEET

FOR PERMITTING ONLY

THE INFORMATION SHOWN ON THE DRAWING IS SOLELY FOR USE BY NATIONAL GRID OR THE NATIONAL GRID'S DESIGNATED REPRESENTATIVE FOR THE SPECIFIC PROJECT AND LOCATION IDENTIFIED ON THE DRAWING. THE DRAWING SHALL NOT BE TRANSFERRED, REUSED, COPIED, OR ALTERED IN ANY MANNER FOR USE AT ANY OTHER LOCATION OR FOR ANY OTHER PURPOSE WITHOUT THE PRIOR WRITTEN CONSENT OF GZA AND NATIONAL GRID. ANY TRANSFER, REUSE, OR MODIFICATION TO THE DRAWING BY OTHERS, WITHOUT THE PRIOR WRITTEN EXPRESS CONSENT OF GZA AND NATIONAL GRID, WILL BE AT THE USER'S SOLE RISK AND WITHOUT ANY RISK OR LIABILITY TO GZA AND NATIONAL GRID.



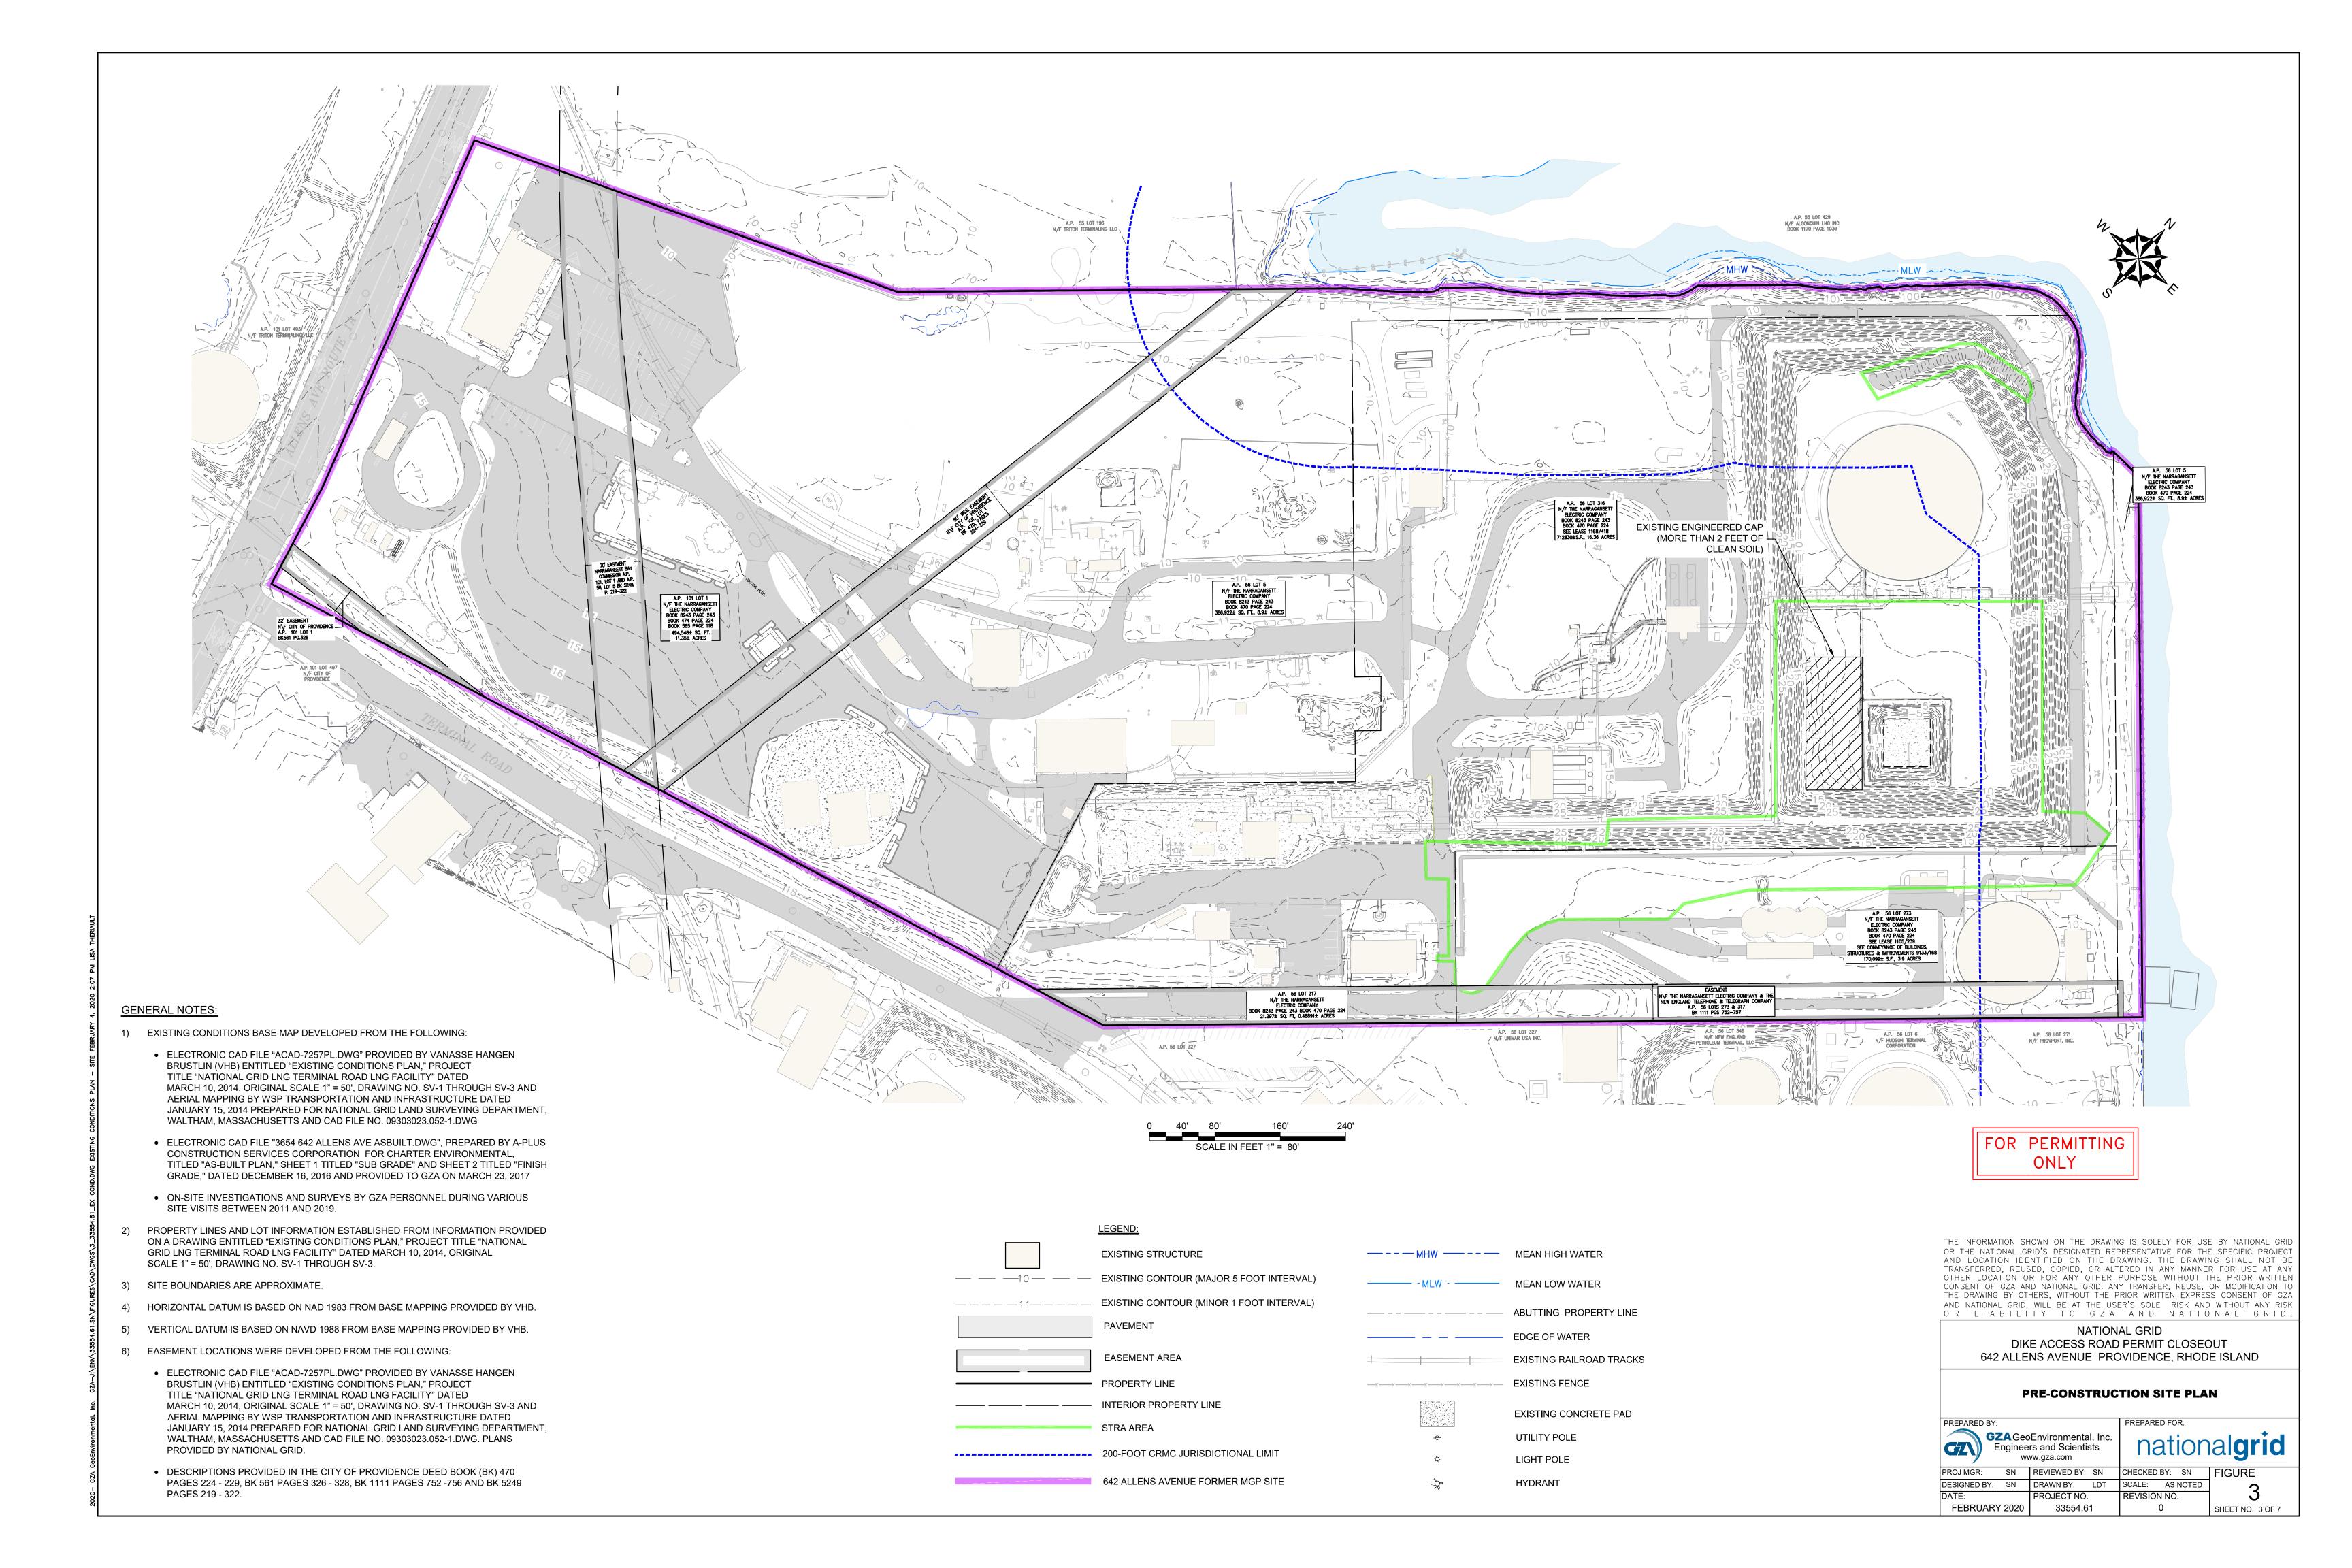

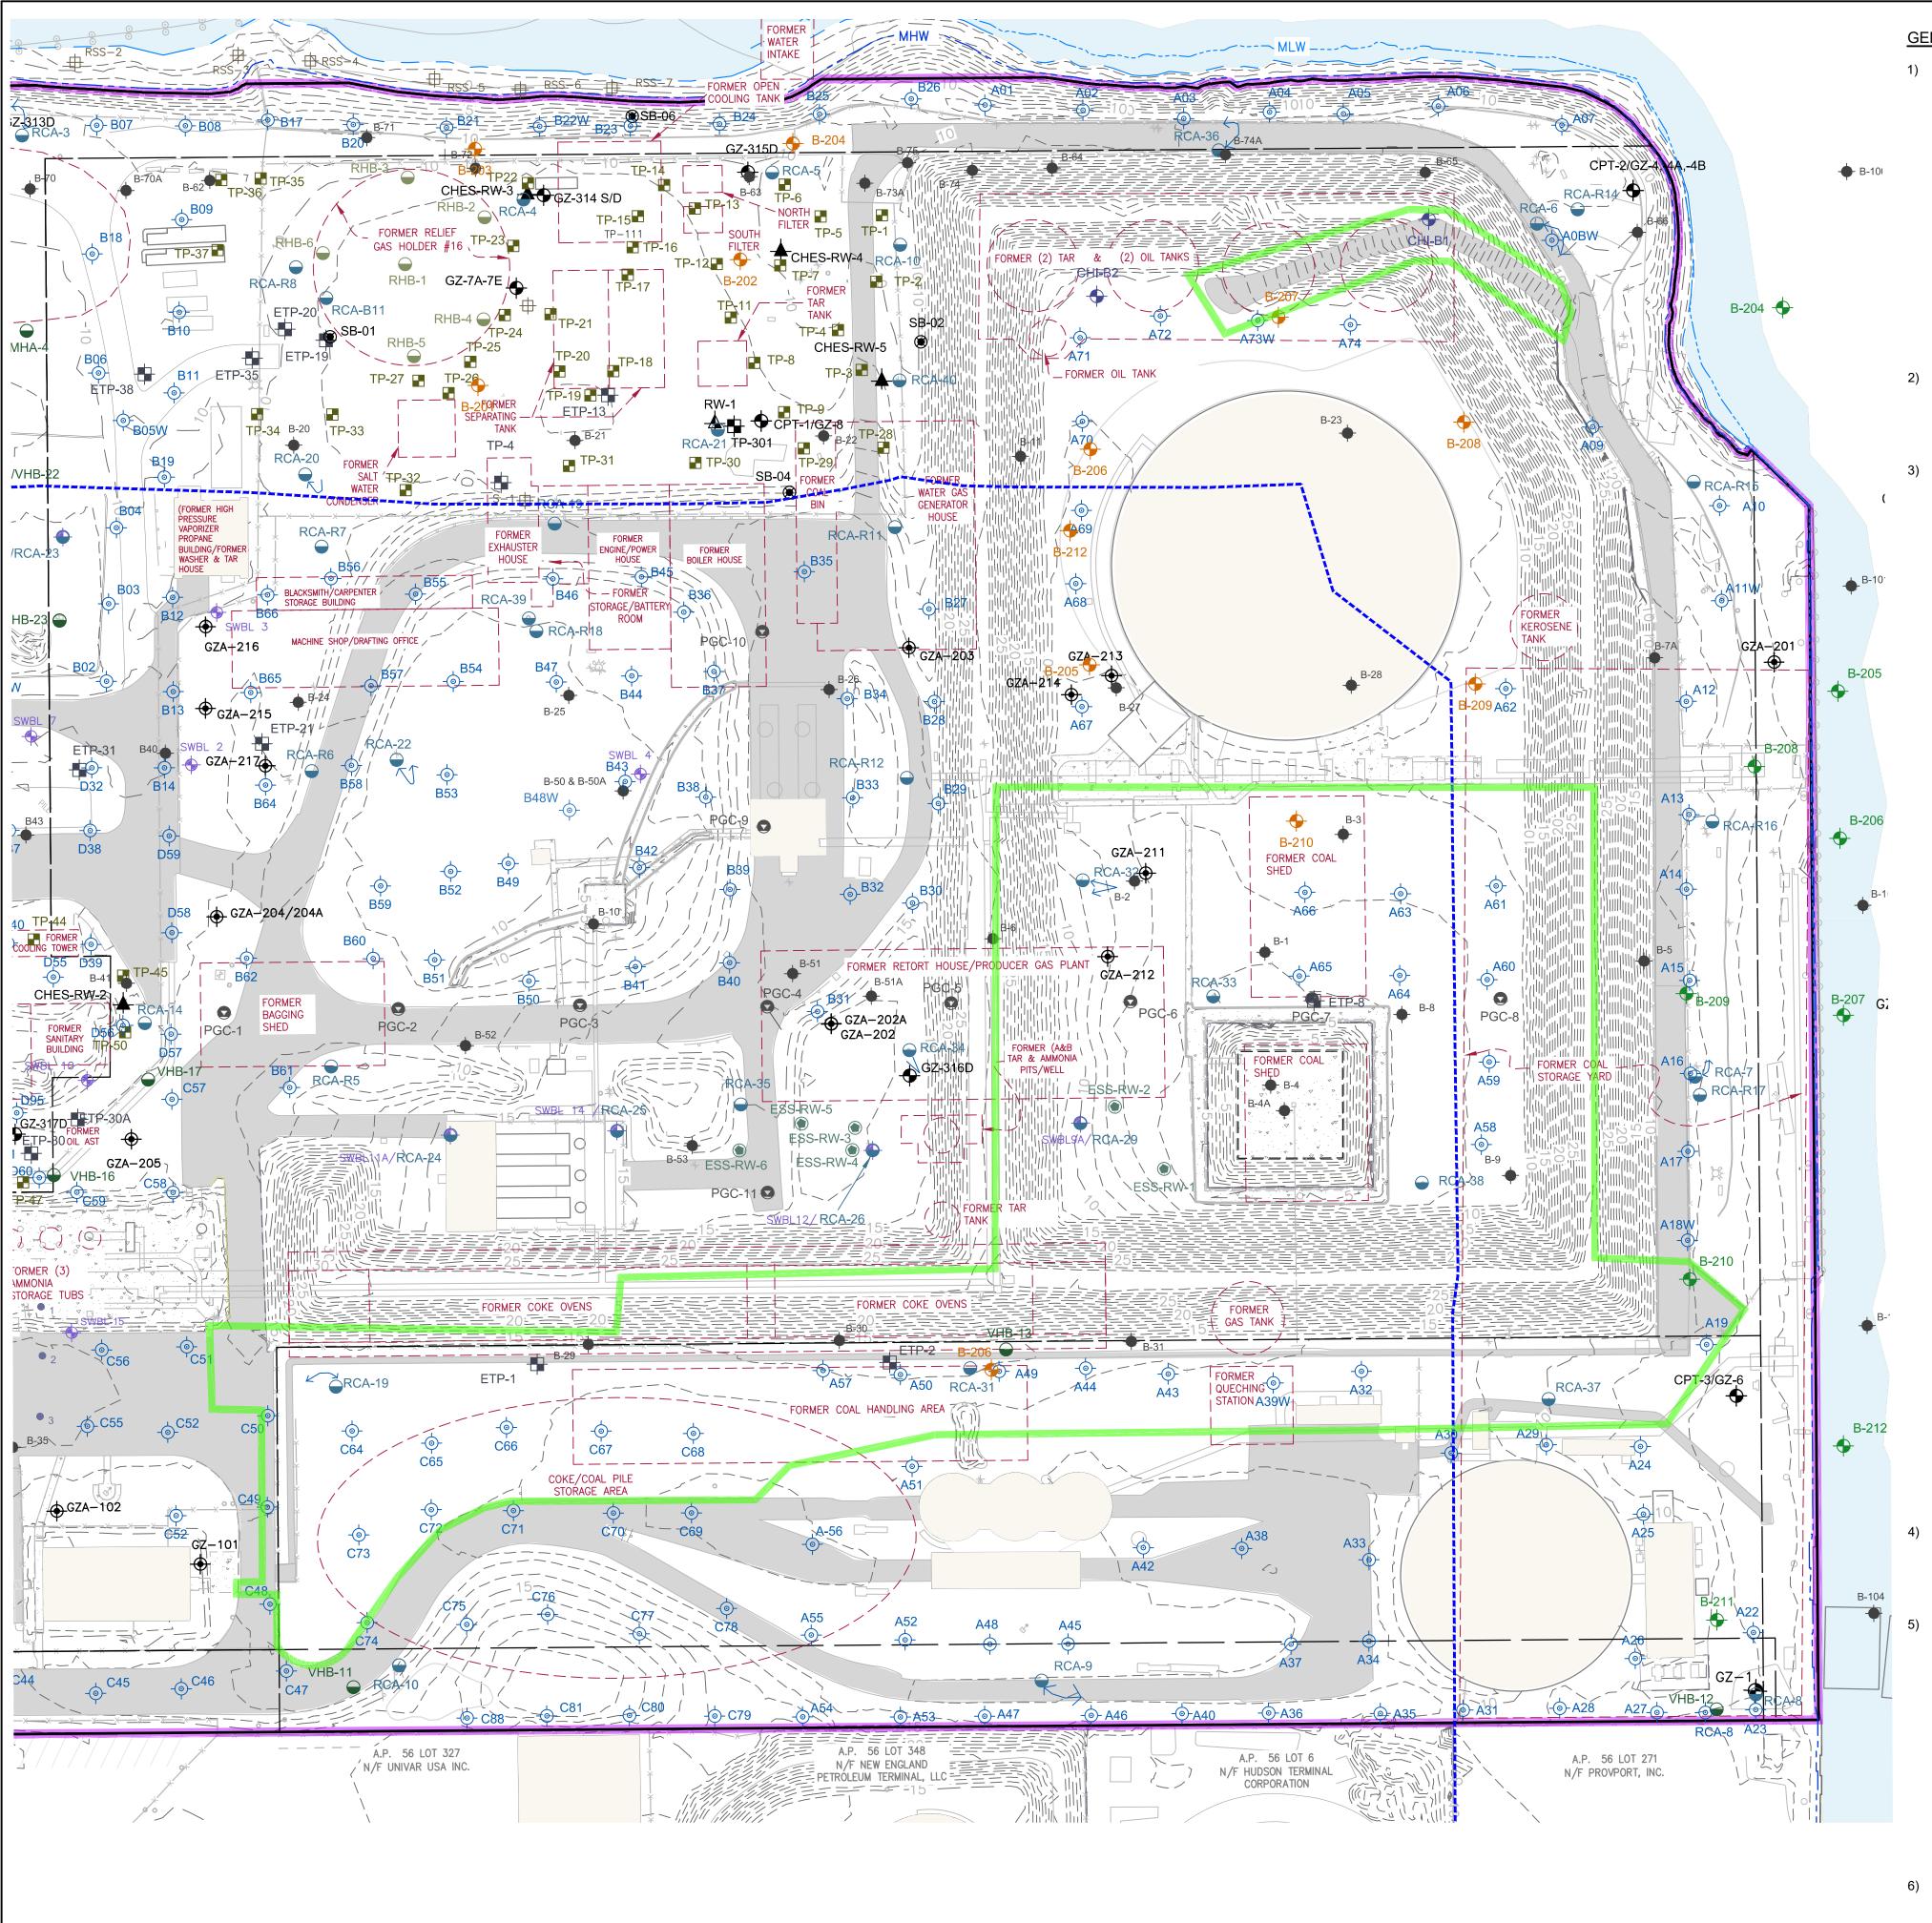


GENERAL NOTES:

- 1) EXISTING CONDITIONS BASE MAP DEVELOPED FROM THE FOLLOWING:
 - ELECTRONIC CAD FILE "ACAD-7257PL.DWG" PROVIDED BY VANASSE HANGEN BRUSTLIN (VHB) ENTITLED "EXISTING CONDITIONS PLAN," PROJECT TITLE "NATIONAL GRID LNG TERMINAL ROAD LNG FACILITY" DATED MARCH 10, 2014, ORIGINAL SCALE 1" = 50', DRAWING NO. SV-1 THROUGH SV-3 AND AERIAL MAPPING BY WSP TRANSPORTATION AND INFRASTRUCTURE DATED JANUARY 15, 2014 PREPARED FOR NATIONAL GRID LAND SURVEYING DEPARTMENT, WALTHAM, MASSACHUSETTS AND CAD FILE NO. 09303023.052-1.DWG.
 - ELECTRONIC CAD FILE "3654 642 ALLENS AVE ASBUILT.DWG", PREPARED BY A-PLUS CONSTRUCTION SERVICES CORPORATION FOR CHARTER ENVIRONMENTAL, TITLED "AS-BUILT PLAN," SHEET 1 TITLED "SUB GRADE" AND SHEET 2 TITLED "FINISH GRADE," DATED DECEMBER 16, 2016 AND PROVIDED TO GZA ON MARCH 23, 2017
 - ON-SITE INVESTIGATIONS AND SURVEYS BY GZA PERSONNEL DURING VARIOUS SITE VISITS BETWEEN 2011 AND 2015.
- 2) PROPERTY LINES AND LOT INFORMATION ESTABLISHED FROM INFORMATION PROVIDED ON A DRAWING ENTITLED "EXISTING CONDITIONS PLAN," PROJECT TITLE "NATIONAL GRID LNG TERMINAL ROAD LNG FACILITY" DATED MARCH 10, 2014, ORIGINAL SCALE 1" = 50', DRAWING NO. SV-1 THROUGH SV-3.
- EXPLORATION LOCATION PLANS WERE DEVELOPED FROM THE FOLLOWING:
- SITE PLANS PROVIDED BY RESOURCE CONTROLS
 ASSOCIATES (RCA) IN THE RIDEM-SUBMITTED JULY 5, 1994 "SITE
 CHARACTERIZATION PLAN" PREPARED ON BEHALF OF THE
 PROVIDENCE GAS COMPANY. PLANS PROVIDED BY NATIONAL GRID.
- SITE PLANS PROVIDED BY RCA IN THE RIDEM-SUBMITTED
 JUNE 28, 1996 "PHASE IB FIELD CHARACTERIZATION
 INVESTIGATION" PREPARED ON BEHALF OF THE PROVIDENCE GAS
 COMPANY. PLANS PROVIDED BY NATIONAL GRID.
- SITE PLANS PROVIDED BY ENVIRONMENTAL SCIENCE SERVICES, INC. (ESS) IN THE RIDEM-SUBMITTED DECEMBER 4, 1998 "REMEDIAL ACTION WORK PLAN (RAWP)" PREPARED ON BEHALF OF THE PROVIDENCE GAS COMPANY. PLANS PROVIDED BY NATIONAL GRID.
- SITE PLANS PROVIDED BY ESS IN THE RIDEM-SUBMITTED
 OCTOBER 21, 1999 "SUBSURFACE INVESTIGATION AND PROPOSED
 ALGONQUIN GENERATOR CONSTRUCTION AREA" PREPARED ON
 BEHALF OF THE PROVIDENCE GAS COMPANY. PLANS PROVIDED BY
 NATIONAL GRID.
- SITE PLANS PROVIDED BY VHB IN THE RIDEM-SUBMITTED NOVEMBER 2002 "REMEDIAL ACTION CLOSURE REPORT" PREPARED ON BEHALF OF THE NEW ENGLAND GAS COMPANY. PLANS PROVIDED BY NATIONAL GRID.
- SITE PLANS PROVIDED BY VHB IN THE RIDEM-SUBMITTED APRIL 2003 "SITE INVESTIGATION REPORT" PREPARED ON BEHALF OF THE NEW ENGLAND GAS COMPANY. PLANS PROVIDED BY NATIONAL GRID.
- JANUARY 26, 2009 "OXIDE BOX INVESTIGATION TECHNICAL MEMORANDUM" PREPARED ON BEHALF OF NATIONAL GRID. PLANS PROVIDED BY NATIONAL GRID.


• SITE PLANS PROVIDED BY VHB IN THE RIDEM-SUBMITTED

- FIGURE 3 "EXPLORATION LOCATION PLAN" PREPARED BY GZA GEOENVIRONMENTAL, INC. (GZA) ON BEHALF OF CHICAGO BRIDGE AND IRON (CB&I) IN JULY 2005. PLANS PROVIDED BY NATIONAL GRID.
- FIGURE 35 "TEST BORINGS UNDER SASSAFRAS POINT PLAT" DATED JUNE 5, 1912 PREPARED BY THE PROVIDENCE GAS COMPANY. PLANS PROVIDED BY NATIONAL GRID.
- DRAWING 3 "WHARF FACILITIES BULKHEAD REBUILDING CROSS SECTIONS" DATED JANUARY 11, 1973 PREPARED BY PARSONS, BRINCKERHOFF, QUADE AND DOUGLAS ON BEHALF OF THE PROVIDENCE GAS COMPANY. PLANS PROVIDED BY NATIONAL GRID.
- FIGURE 2 "EXPLORATION LOCATION PLAN," DATED SEPTEMBER 18, 2015, BY WEIDLINGER ASSOCIATES, INC. (WEI) ON BEHALF OF KIEWIT CORPORATION (KIEWIT). PLAN PROVIDED BY NATIONAL GRID.
- ELECTRONIC CAD FILE "ACAD-7257PL.DWG" PROVIDED BY VANASSE HANGEN BRUSTLIN (VHB) ENTITLED "EXISTING CONDITIONS PLAN," PROJECT TITLE "NATIONAL GRID LNG TERMINAL ROAD LNG FACILITY" DATED MARCH 10, 2014, ORIGINAL SCALE 1" = 50', DRAWING NO. SV-1 THROUGH SV-3 AND AERIAL MAPPING BY WSP TRANSPORTATION AND INFRASTRUCTURE DATED JANUARY 15, 2014 PREPARED FOR NATIONAL GRID LAND SURVEYING DEPARTMENT, WALTHAM, MASSACHUSETTS AND CAD FILE NO. 09303023.052-1.DWG. PLANS PROVIDED BY NATIONAL GRID.
- ON-SITE INVESTIGATIONS AND SURVEYS BY GZA PERSONNEL DURING VARIOUS SITE VISITS BETWEEN 2011 AND 2015.
- 4) THE LOCATION OF THE EXPLORATIONS AND MONITORING WELLS AT THE SITE WERE APPROXIMATELY DETERMINED AND HAVE BEEN ALIGNED AND ADJUSTED FOR THE "BEST FIT" AND THESE DATA SHOULD BE CONSIDERED ACCURATE ONLY TO THE DEGREE IMPLIED BY THE METHOD USED.
- APPROXIMATE HISTORICAL STRUCTURE/EQUIPMENT LOCATIONS AND DATES WERE OBTAINED FROM THE FOLLOWING SOURCES:
- CERTIFIED SANBORN MAPS DATED: 1950, 1956, 1972, 1977 AND 1982
- AERIAL ORTHOPHOTOGRAPHIC IMAGES OBTAINED FROM RIGIS: 1939, 1951, 1962, 1972, 1976, 1981, 1988, 1992, 1995, 1997, 2002, 2008
- SITE PLANS PROVIDED BY RESOURCE CONTROLS
 ASSOCIATES (RCA) IN THE RIDEM-SUBMITTED JULY 5, 1994 "SITE CHARACTERIZATION PLAN" PREPARED ON BEHALF OF THE
- PROVIDENCE GAS COMPANY. PLANS PROVIDED BY NATIONAL GRID.
 HISTORIC SITE PLAN "GENERAL PLAN OF WORKS, PROVIDENCE GAS COMPANY, SASSAFRAS POINT PLANT, PROVIDENCE, RHODE
- 6) HORIZONTAL DATUM IS BASED ON NAD 1983 FROM BASE MAPPING PROVIDED BY VHB.
- 7) VERTICAL DATUM IS BASED ON NAVD 1988 (MSL) FROM BASE MAPPING PROVIDED BY VHB.

ISLAND." UNDATED. PLANS PROVIDED BY NATIONAL GRID.

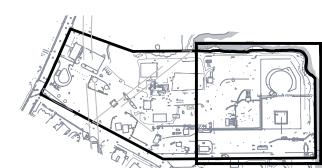

KEY PLAN:

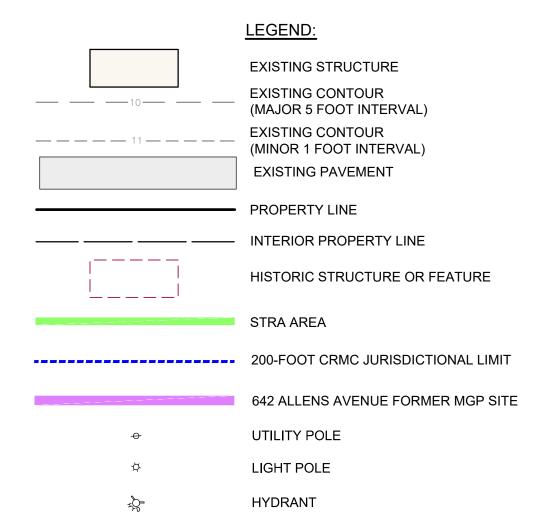

EXPLORATION LEGEND:

RCA-40	ENVIRONMENTAL BORING OBSERVED BY RCA BETWEEN 1994-1996
ETP-4	ENVIRONMENTAL TEST PITS OBSERVED BY RCA IN 1995 AND 1996
ESS-RW-1	RECOVERY WELL INSTALLED BY ESS IN 1999 AND 2000
CPT-3/GZ-	GEOTECHNICAL BORING OBSERVED BY GZA IN 2004
SWBL13 +	GEOTECHNICAL BORING OBSERVED BY SWEC IN 1995
B-207	GEOTECHNICAL BORING PERFORMED FOR PROVIDENCE GAS COMPANY IN 1973
B-25 -	GEOTECHNICAL BORING OBSERVED BY HALEY & ALDRICH IN 1971 AND 1972
PGC-8	GEOTECHNICAL BORING PERFORMED FOR PROVIDENCE GAS COMPANY IN 1912
B-211 💠	GEOTECHNICAL BORING PERFORMED BY GOLDER ASSOCIATES IN 2016
W155	CONFIRMATORY SOIL SAMPLE LOCATION COLLECTED BY ESS IN 1999

VHB-7 ENVIRONMENTAL BORING OBSERVED BY VHB IN 2002 AND 2003

DCA 40 C FNVIDONIMENTAL DODING ODCEDVED BY DCA DETWEEN 4004 4006

ENVIRONMENTAL BORING OBSERVED BY ESS IN 1999 AND 2000




CHI-B1 GEOTECHNICAL BORING PERFORMED BY CHI IN 2014



CHECKED BY: SN FIGURE

SHEET NO. 4 OF 7

SCALE: AS NOTED REVISION NO.

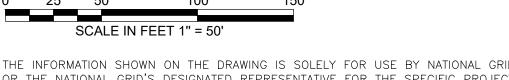


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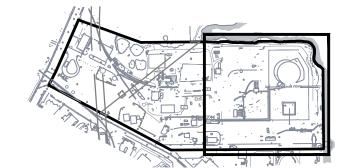
SN REVIEWED BY: SN

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DESIGNED BY: SN DRAWN BY: LDT

FEBRUARY 2020



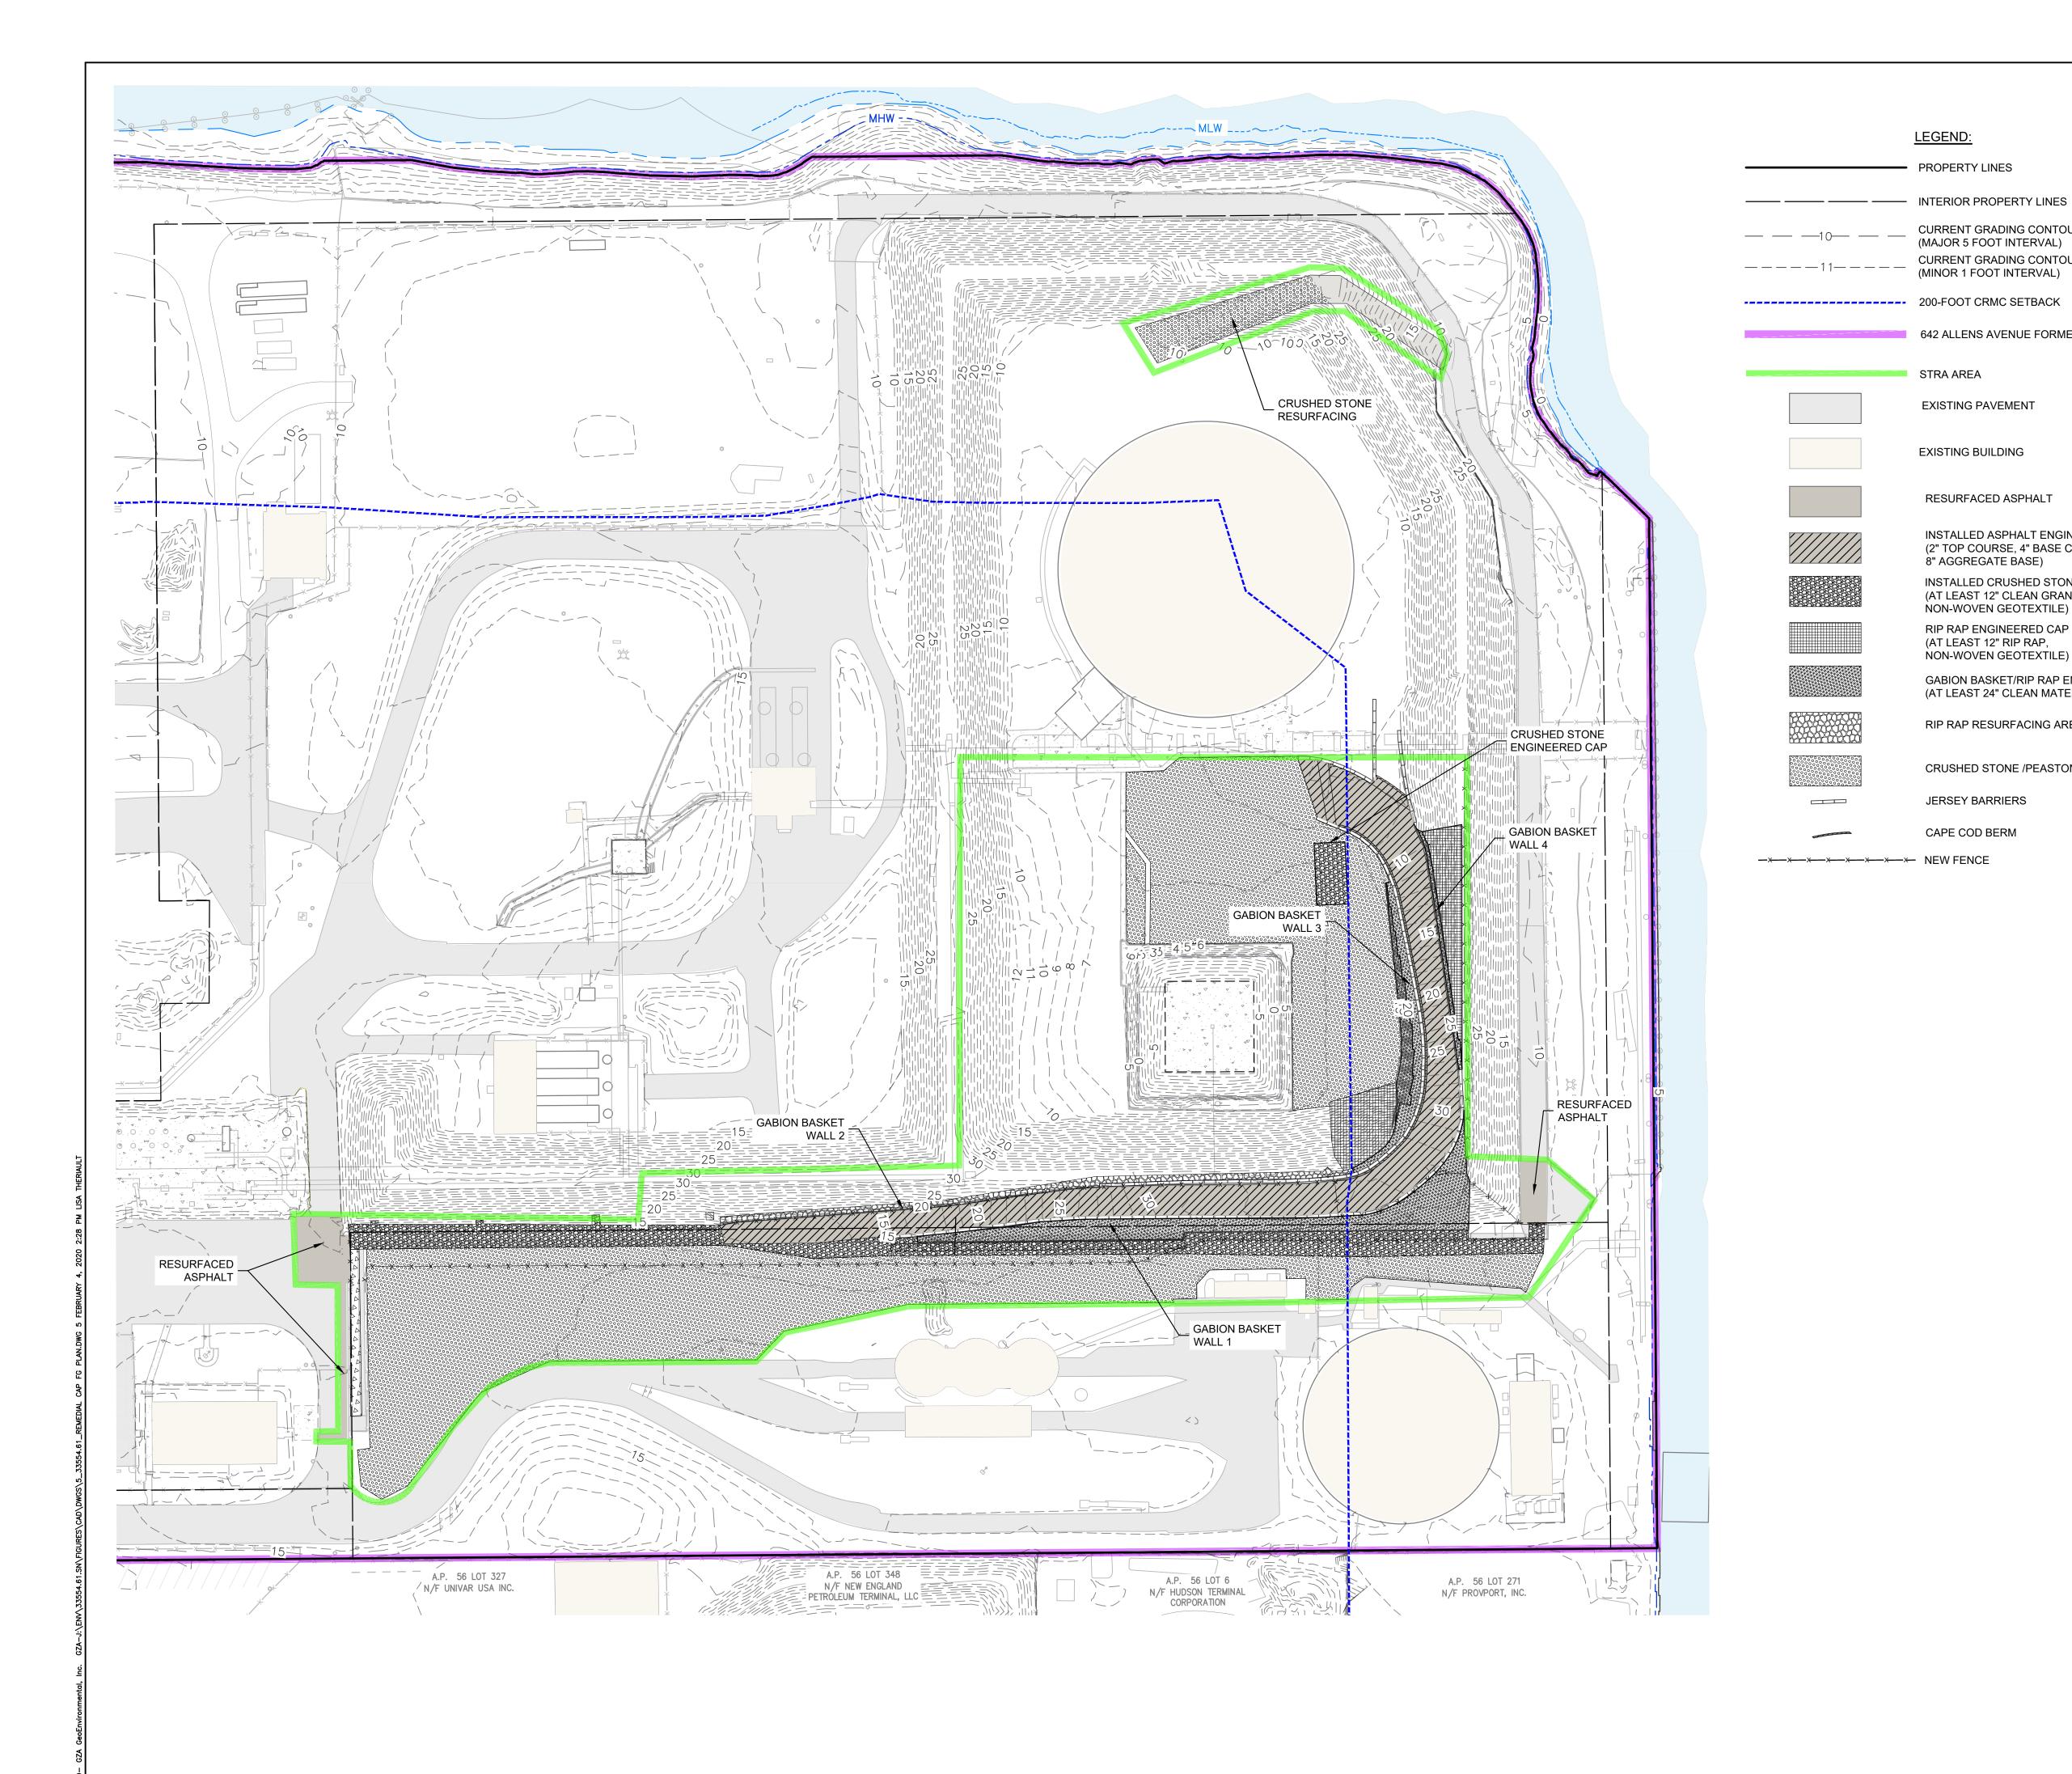

KEY PLAN: SCALE: 1"=800'

GENERAL NOTES:

LEGEND:

PROPERTY LINES

STRA AREA

EXISTING PAVEMENT

EXISTING BUILDING

RESURFACED ASPHALT

8" AGGREGATE BASE)

NON-WOVEN GEOTEXTILE)

RIP RAP ENGINEERED CAP (AT LEAST 12" RIP RAP,

NON-WOVEN GEOTEXTILE)

(AT LEAST 24" CLEAN MATERIAL)

RIP RAP RESURFACING AREA

JERSEY BARRIERS

CAPE COD BERM

INSTALLED ASPHALT ENGINEERED CAP (2" TOP COURSE, 4" BASE COURSE,

(AT LEAST 12" CLEAN GRANULAR IMPORT,

INSTALLED CRUSHED STONE ENGINEERED CAP

GABION BASKET/RIP RAP ENGINEERED WALL

CRUSHED STONE /PEASTONE RESURFACING

CURRENT GRADING CONTOUR (MAJOR 5 FOOT INTERVAL) **CURRENT GRADING CONTOUR**

642 ALLENS AVENUE FORMER MGP SITE

(MINOR 1 FOOT INTERVAL)

- 1) EXISTING CONDITIONS BASE MAP DEVELOPED FROM THE FOLLOWING:
 - ELECTRONIC CAD FILE "ACAD-7257PL.DWG" PROVIDED BY VANASSE HANGEN BRUSTLIN (VHB) ENTITLED "EXISTING CONDITIONS PLAN," PROJECT TITLE "NATIONAL GRID LNG TERMINAL ROAD LNG FACILITY" DATED MARCH 10, 2014, ORIGINAL SCALE 1" = 50', DRAWING NO. SV-1 THROUGH SV-3 AND AERIAL MAPPING BY WSP TRANSPORTATION AND INFRASTRUCTURE DATED JANUARY 15, 2014 PREPARED FOR NATIONAL GRID LAND SURVEYING DEPARTMENT, WALTHAM, MASSACHUSETTS AND CAD FILE NO. 09303023.052-1.DWG
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- 2) AS-BUILT DEVELOPED FROM AN ELECTRONIC CAD FILE "19-NG-20_TERMINAL-RD PROVIDENCE.DWG," PREPARED BY TAUPER LAND SURVEY, INC. ON DECEMBER 30, 2019 FOR NATIONAL GRID LAND SURVEYING DEPARTMENT, WALTHAM, MASSACHUSETTS.
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- 4) SITE BOUNDARIES ARE APPROXIMATE.
- 5) HORIZONTAL DATUM IS BASED ON NAD 1983 FROM BASE MAPPING PROVIDED BY VHB.
- 6) VERTICAL DATUM IS BASED ON NAVD 1988 FROM BASE MAPPING PROVIDED BY VHB.






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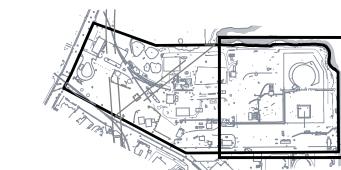
NATIONAL GRID DIKE ACCESS ROAD PERMIT CLOSEOUT 642 ALLENS AVENUE PROVIDENCE, RHODE ISLAND

REMEDIAL CAP FINAL GRADING PLAN

GZA GeoEnvironmental, Inc. Engineers and Scientists www.gza.com

PROJ MGR: SN REVIEWED BY: SN CHECKED BY: SN FIGURE DESIGNED BY: SN DRAWN BY: LDT SCALE: AS NOTED FEBRUARY 2020 33554.61 SHEET NO. 5 OF 7



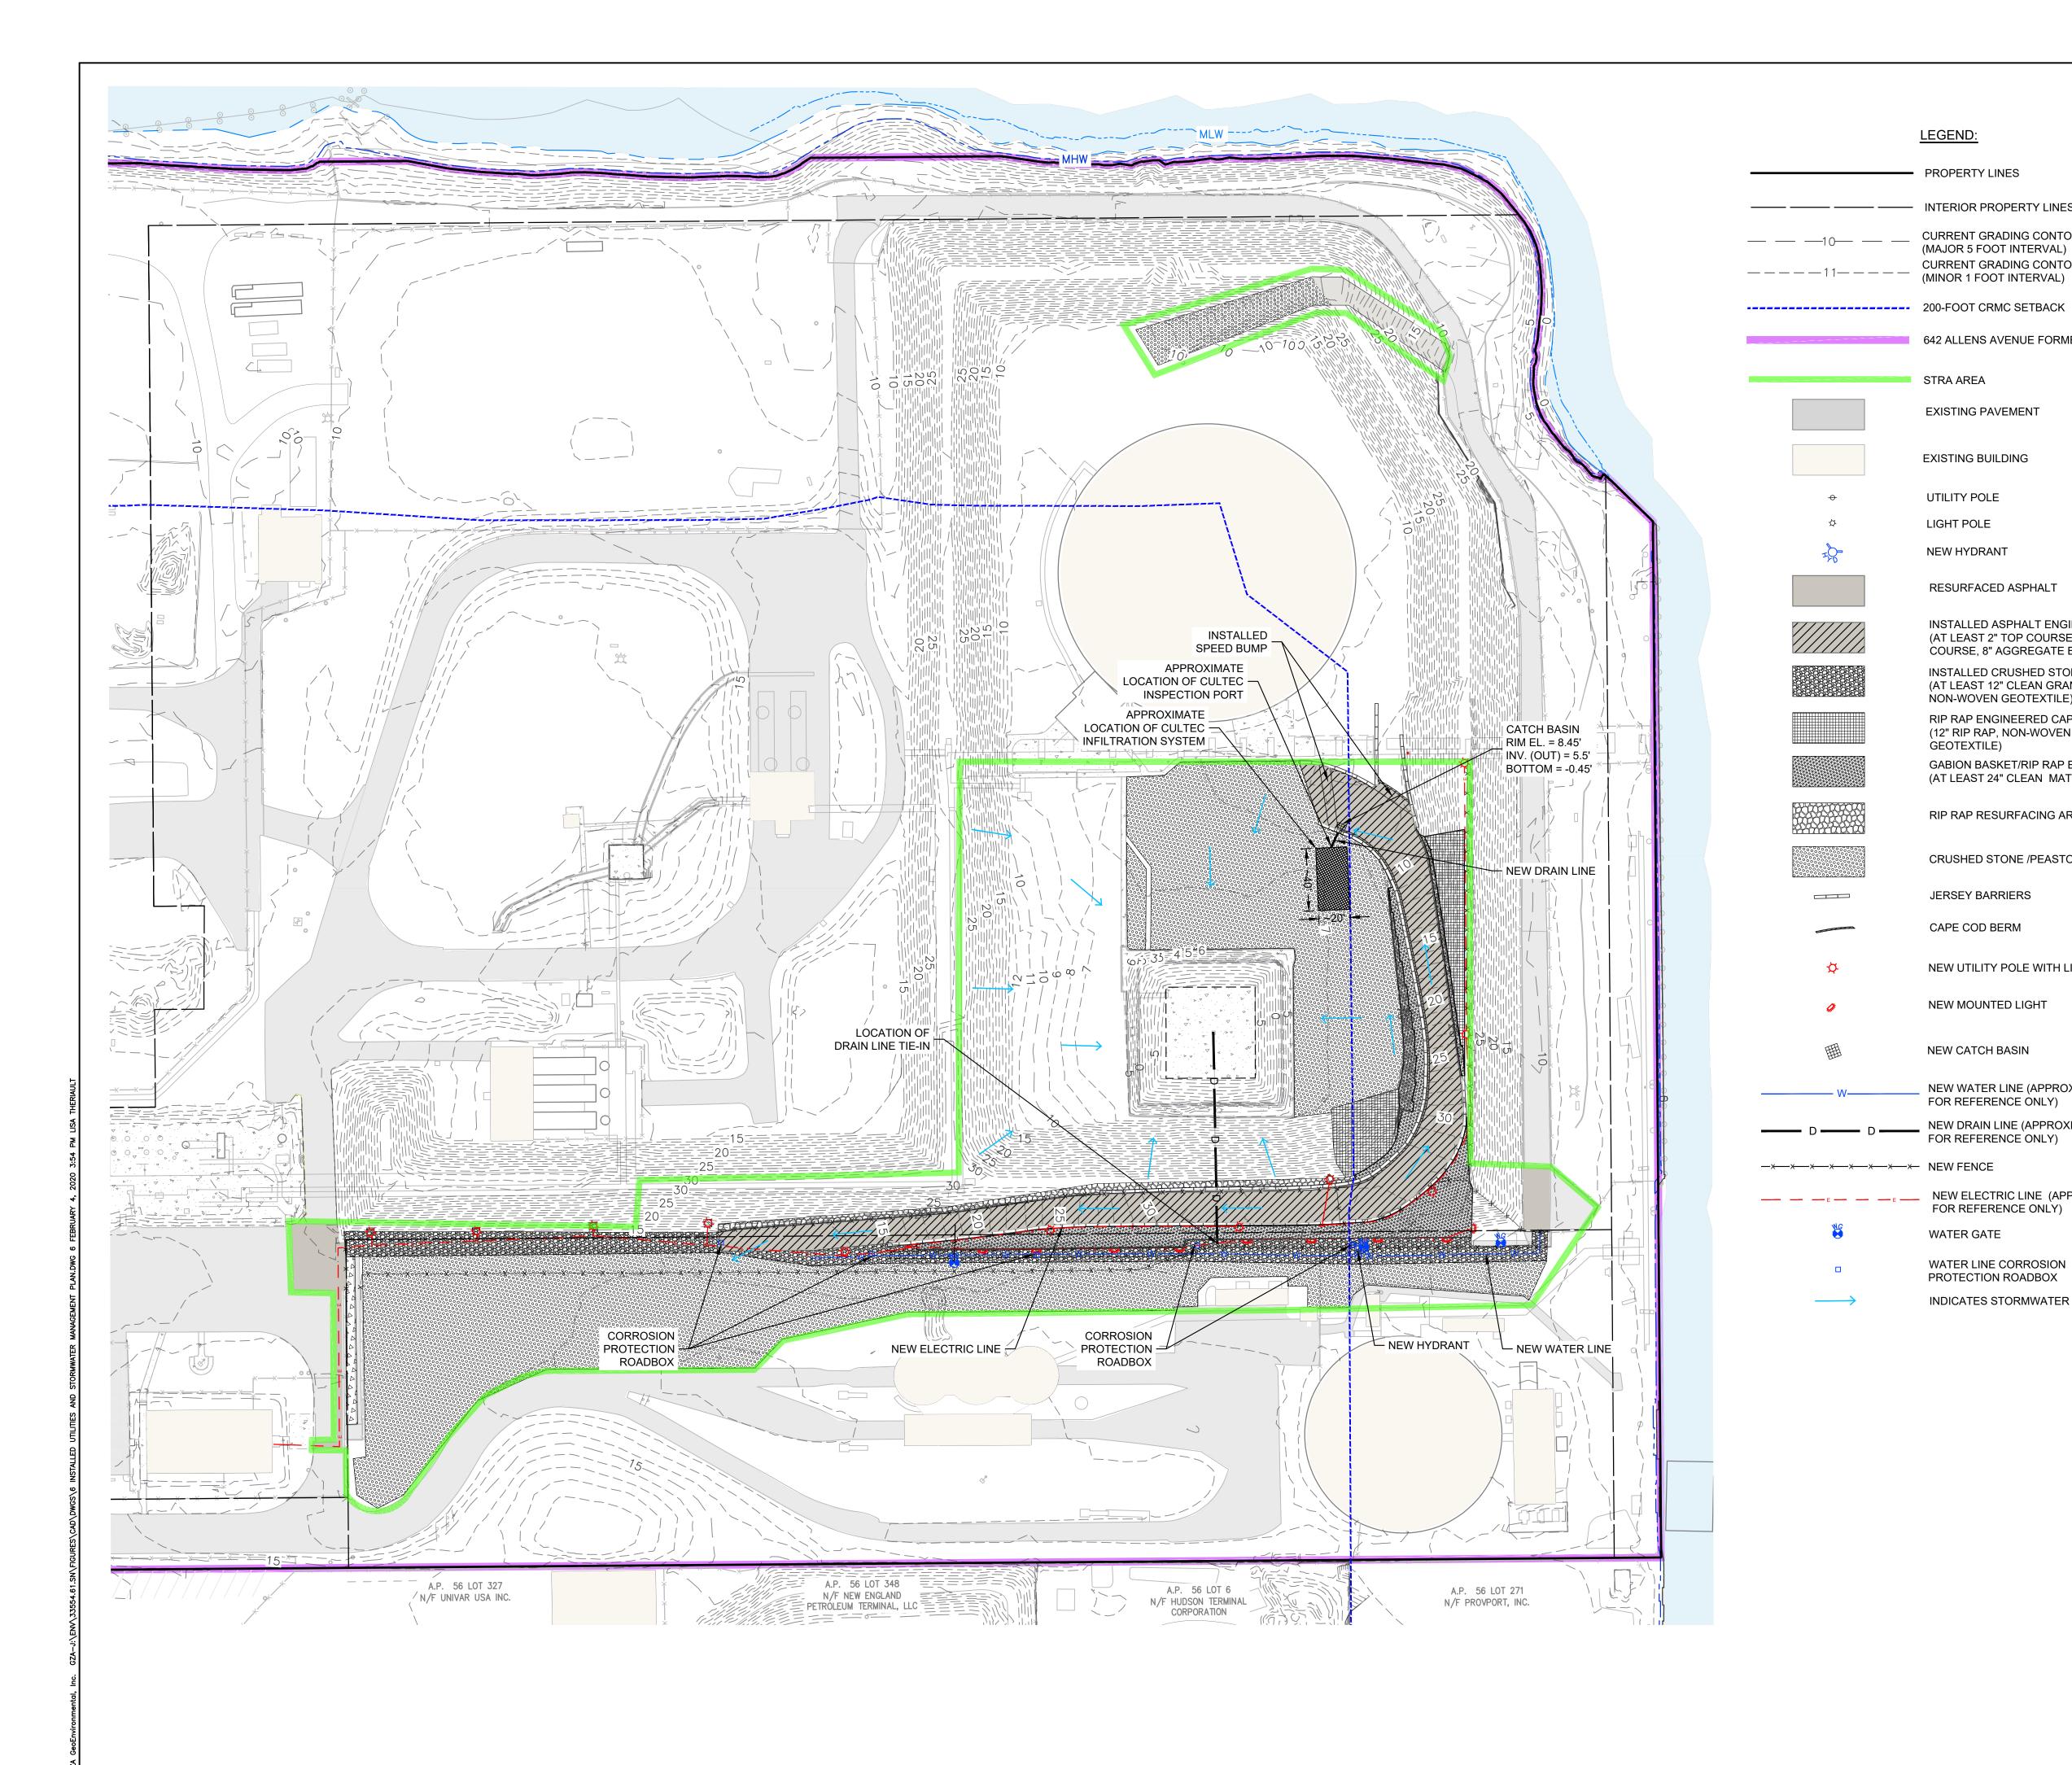

KEY PLAN: SCALE: 1"=800'

GENERAL NOTES:

LEGEND:

PROPERTY LINES

STRA AREA

EXISTING PAVEMENT

EXISTING BUILDING

UTILITY POLE

LIGHT POLE

NEW HYDRANT

RESURFACED ASPHALT

INSTALLED ASPHALT ENGINEERED CAP

(AT LEAST 12" CLEAN GRANULAR IMPORT,

INSTALLED CRUSHED STONE ENGINEERED CAP

GABION BASKET/RIP RAP ENGINEERED WALL

CRUSHED STONE /PEASTONE RESURFACING

NEW WATER LINE (APPROXIMATE LOCATION -

NEW DRAIN LINE (APPROXIMATE LOCATION -

NEW ELECTRIC LINE (APPROXIMATE LOCATION -

(AT LEAST 2" TOP COURSE, 4" BASE

COURSE, 8" AGGREGATE BASE)

NON-WOVEN GEOTEXTILE)

RIP RAP ENGINEERED CAP

(12" RIP RAP, NON-WOVEN

(AT LEAST 24" CLEAN MATERIAL)

RIP RAP RESURFACING AREA

NEW UTILITY POLE WITH LIGHT

GEOTEXTILE)

JERSEY BARRIERS

CAPE COD BERM

NEW MOUNTED LIGHT

FOR REFERENCE ONLY)

FOR REFERENCE ONLY)

FOR REFERENCE ONLY)

WATER LINE CORROSION PROTECTION ROADBOX

INDICATES STORMWATER FLOW

WATER GATE

NEW CATCH BASIN

— — INTERIOR PROPERTY LINES

CURRENT GRADING CONTOUR (MAJOR 5 FOOT INTERVAL) CURRENT GRADING CONTOUR

642 ALLENS AVENUE FORMER MGP SITE

(MINOR 1 FOOT INTERVAL)

- 1) EXISTING CONDITIONS BASE MAP DEVELOPED FROM THE FOLLOWING:
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- 4) SITE BOUNDARIES ARE APPROXIMATE.
- 5) LOCATION OF UTILITIES IS APPROXIMATE AND INCLUDED FOR REFERENCE ONLY)
- 6) HORIZONTAL DATUM IS BASED ON NAD 1983 FROM BASE MAPPING PROVIDED BY VHB.
- 7) VERTICAL DATUM IS BASED ON NAVD 1988 FROM BASE MAPPING PROVIDED BY VHB.





SCALE IN FEET 1" = 50'

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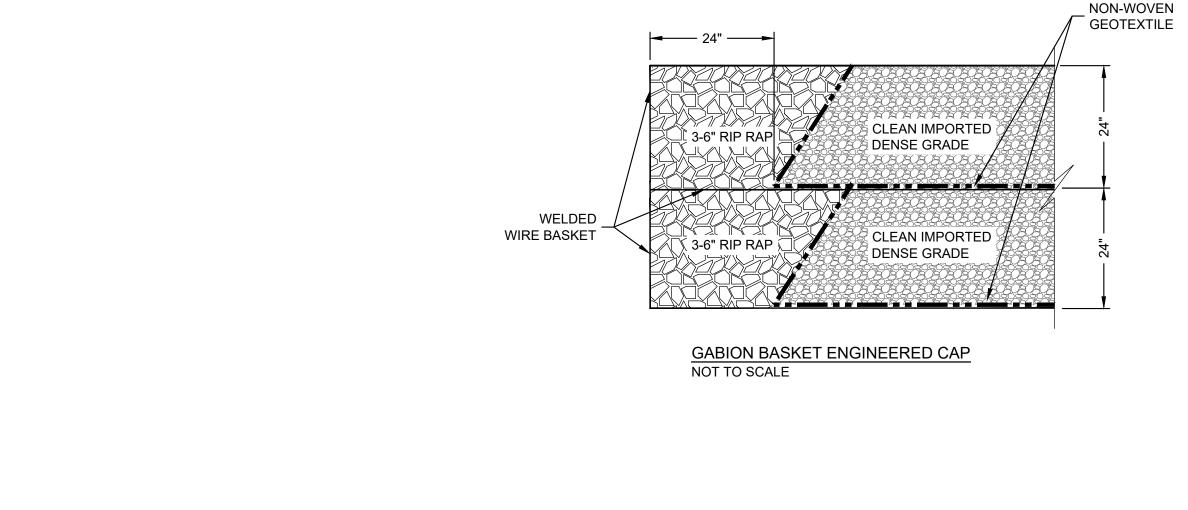
> DIKE ACCESS ROAD PERMIT CLOSEOUT 642 ALLENS AVENUE PROVIDENCE, RHODE ISLAND


NATIONAL GRID


INSTALLED UTILITIES AND STORMWATER MANAGEMENT PLAN


PREPARED BY: GZA GeoEnvironmental, Inc. Engineers and Scientists www.gza.com

PROJ MGR: SN REVIEWED BY: SN CHECKED BY: SN FIGURE DESIGNED BY: SN DRAWN BY: LDT SCALE: AS NOTED FEBRUARY 2020 33554.61 SHEET NO. 6 OF 7



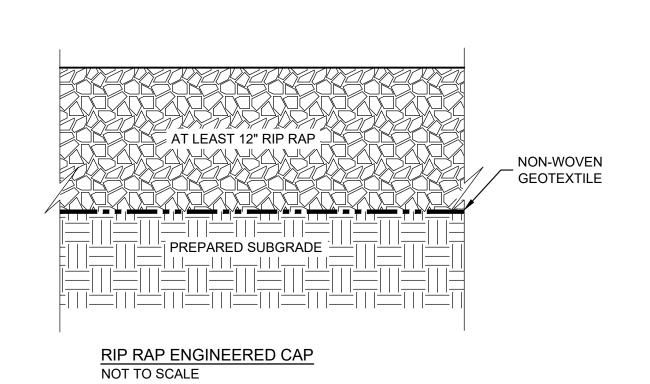

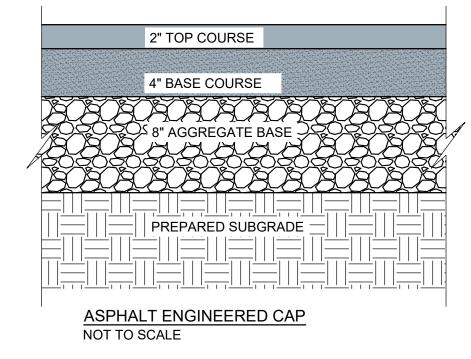

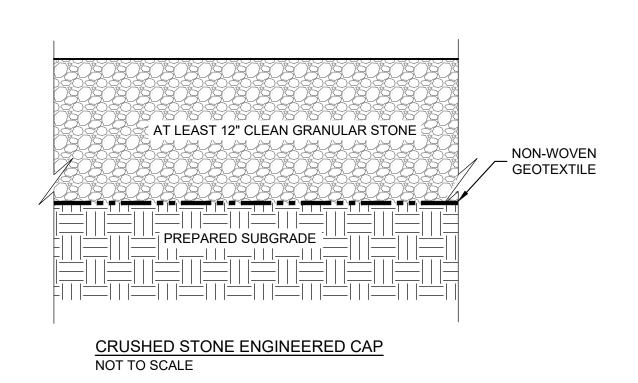

FOR PERMITTING

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NATIONAL GRID DIKE ACCESS ROAD PERMIT CLOSEOUT 642 ALLENS AVENUE PROVIDENCE, RHODE ISLAND

REMEDIAL CAP DETAILS

PREPARED BY: GZA GeoEnvironmental, Inc. Engineers and Scientists

SHEET NO. 7 OF 7

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ATTACHMENT C

NOTICE OF TERMINATION FORM

NOTICE OF TERMINATION (NOT)

STORMWATER GENERAL PERMIT FOR CONSTRUCTION ACTIVITY

INSTRUCTIONS:

Use this form to notify RIDEM upon project completion, confirming that work has been completed in accordance with approved plans and final site stabilization was achieved on **Stormwater Construction** permitted sites.

Submit forms by email to: DEM.StwConstruction@dem.ri.gov or by mail to:

Permit Application Center (PAC), RIDEM, 235 Promenade Street, Room 260, Providence, RI 02908.

Provide <u>all</u> file numbers associated with this site.

RIPDES Permit Authorization to be terminated:	Freshwater Wetlands Permit:	NA
RIR 101439	Water Quality Certification File:	16-115
	UIC/Groundwater Discharge File:	001729

I. OWNER

Name:	Narragansett Electric Co. dba National Grid	Email:	william.howard@nationalgrid.com			
Mailing Address:	280 Melrose Street	Phone:	401-784-7490			
City:	Providence	State:	RI	Zip:	02907	
Contact Person:	William Howard	Title:		-		

II. OPERATOR (if different from Owner)

Name:	Email:		
Mailing Address:	Phone:		
City:	State:	Zip:	
Contact Person:	Title:		

III. CONSTRUCTION SITE INFORMATION

Street Address:	121 Terminal Road			Phone:			
City:	Providence S		State:	RI	Zip:	02905	
Nearest Utility Pole: Assessor		's Plat:	56	Lot:	273, 316		
Date land disturbing activities ceased (required):			June 7, 2019				
Date final site stabilization was achieved (required):			June 7, 2019				

IV. OWNER & OPERATOR CERTIFICATION

I certify under penalty of law that all disturbed soils at the construction site have been stabilized and temporary erosion and sediment control measures have been removed and all stormwater discharges associated with construction activity from the construction site that are authorized by the General Permit have been eliminated. The burden of operating in compliance with applicable RIPDES Regulations is my responsibility. I am aware that there are significant penalties for submitting false information, including the possibility of fine and imprisonment for knowing violations.

Owner's Name:	William Howard	Owner's Title:	Principal Environmental Scientist
Owner's Signature:	William H Howard)	Date:	02/07/2020
Operator's Name:	ι	Operator Title:	
Operator's Signature:		Date:	